

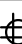
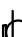
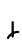

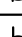


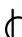













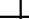






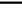


RECEPTACLES		
SYMBOL	DESCRIPTION	MOUNTING
	DUPLEX RECEPTACLE 120V, 20A	18" AFF OR AS NOTED
	DUPLEX RECEPTACLE 120V, 20A (COUNTER HEIGHT (TYP.))	44" AFF OR 6" ABOVE COUNTER
	QUAD RECEPTACLE 120V, 20A	18" AFF OR AS NOTED
	DUPLEX RECEPTACLE W/ USB PORTS 120V, 20A	18" AFF OR AS NOTED
	DUPLEX RECEPTACLE (EXISTING TO REMAIN)	AS NOTED
	DUPLEX RECEPTACLE (HALF SWITCHED) 120V, 20A	18" AFF OR AS NOTED
	DUPLEX RECEPTACLE 120V, 20A (PEDESTAL BOX)	CONDUIT ON FLOOR SERVICE FITTING
	QUADRAPLEX RECEPTACLE 120V, 20A (PEDESTAL BOX)	CONDUIT ON FLOOR SERVICE FITTING
	SPECIAL PURPOSE RECEPTACLE	SEE POWER SHEET FOR DETAIL
	CORD DROP RECEPTACLE	SEE POWER SHEET FOR DETAIL
	FLOOR 120V AND DATA SQUARE	FLUSH WITH FLOOR
	CEILING 120V DUPLEX	FLUSH WITH CEILING
	CEILING SPECIAL PURPOSE RECEPTACLE	FLUSH WITH CEILING
RECEPTACLE NOTATIONS		
GFCI	GROUND FAULT CIRCUIT INTERRUPTER	
GFCI/WP	GROUND FAULT CIRCUIT INTERRUPTER / WEATHERPROOF	
WP	WEATHERPROOF	
F	FLUSH W/ FLOOR	
ETR	EXISTING TO REMAIN	


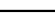


LIGHTING CONTROLS		
SYMBOL	DESCRIPTION	MOUNTING
	SINGLE POLE SWITCH (INDICATES LIGHTS CONTROLLED)	48" AFF OR AS NOTED
	3 WAY SWITCH	48" AFF OR AS NOTED
	DIMMER SWITCH	48" AFF OR AS NOTED
	LOW VOLTAGE SWITCH "LVD" TO DENOTE LOW VOLTAGE DIMMER.	48" AFF OR AS NOTED
	OCCUPANCY SENSOR SWITCH	48" AFF OR AS NOTED
	OCCUPANCY SENSOR	ON CEILING OR AS NOTED
	POWER PACK	ABOVE CEILING
	CEILING MOUNTED INTERIOR DAYLIGHT HARVESTING PHOTOCELL SENSOR	ON CEILING OR AS NOTED




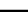






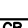
FIRE ALARM		
SYMBOL	DESCRIPTION	MOUNTING
	HEAT DETECTOR	ON CEILING OR AS NOTED
	FIRE ALARM SMOKE DETECTOR	ON CEILING OR AS NOTED
	FIRE ALARM SMOKE DETECTOR (WALL MOUNTED)	WALL MTD. 6" BELOW CLG.
	DUCT TYPE SMOKE DETECTOR	IN HVAC DUCTWORK
	FIRE ALARM CONTROL PANEL	60" AFF TO TOP OR AS NOTED
	FIRE ALARM ANNUNCIATOR	60" AFF TO TOP OR AS NOTED
	SMOKE DAMPER	IN HVAC DUCTWORK
	FLOW AND TAMPER SWITCH	AS NOTED
	FIRE ALARM VISUAL STROBE	80" AFF OR SEE NOTE BELOW
	FIRE ALARM SPEAKER/VISUAL STROBE	80" AFF OR SEE NOTE BELOW
	FIRE ALARM HORN/VISUAL STROBE	80" AFF OR SEE NOTE BELOW
	FIRE ALARM SPEAKER ONLY	80" AFF OR SEE NOTE BELOW
	FIRE ALARM MANUAL PULL STATION	48" AFF OR AS NOTED
	DUCT DETECTOR REMOTE TEST / RESET SWITCH	48" AFF OR AS NOTED
	RELAY MODULE	AS NOTED
	MONITOR MODULE	AS NOTED
	DUAL MONITOR MODULE	AS NOTED






LOW VOLTAGE & DATA		
SYMBOL	DESCRIPTION	MOUNTING
	WIRELESS ACCESS POINT	AS NOTED
	LOW VOLTAGE DUPLEX RECEPTACLE (NUMBER DENOTES QUANTITY OF PORTS)	18" AFF OR AS NOTED
	COUNTER HEIGHT, LOW VOLTAGE DUPLEX RECEPTACLE (NUMBER DENOTES QUANTITY OF PORTS)	ABOVE COUNTER
	TELEPHONE TERMINAL BOARD	AS NOTED
	CABLE TV WALL JACK	AS NOTED




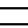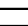
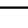






SECURITY		
SYMBOL	DESCRIPTION	MOUNTING
	CARD READER	AS NOTED
	DOOR CONTACT	72" AFF OR AS NOTED
	KEYPAD	48" AFF OR AS NOTED
	MOTION DETECTOR	AS NOTED
	ELECTRIC STRIKE	AS NOTED

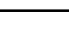

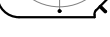

INTERIOR LUMINAIRES		
SYMBOL	DESCRIPTION	MOUNTING
	2x2 LAY-IN FIXTURE EMERGENCY POWER	SEE FIXTURE SCHEDULE
	2x2 LAY-IN FIXTURE (NL - DENOTES NIGHTLIGHT)	SEE FIXTURE SCHEDULE
	2x4 LAY-IN FIXTURE EMERGENCY POWER	SEE FIXTURE SCHEDULE
	2x4 LAY-IN FIXTURE (NL - DENOTES NIGHTLIGHT)	SEE FIXTURE SCHEDULE
	1x4FT STRIP FIXTURE EMERGENCY POWER	SEE FIXTURE SCHEDULE
	1x4FT STRIP FIXTURE	SEE FIXTURE SCHEDULE
	EMERGENCY FIXTURE	SEE FIXTURE SCHEDULE
	EMERGENCY EXIT COMBINATION FIXTURE	SEE FIXTURE SCHEDULE
	EXIT FIXTURE - DIRECTION DENOTED	SEE FIXTURE SCHEDULE
	EXTERIOR EGRESS FIXTURE	SEE FIXTURE SCHEDULE
	PENDANT FIXTURE	SEE FIXTURE SCHEDULE
	DOWN LIGHT EMERGENCY FIXTURE	SEE FIXTURE SCHEDULE
	DOWN LIGHT	SEE FIXTURE SCHEDULE
	WALL MOUNTED FIXTURE	SEE FIXTURE SCHEDULE
	LIGHT FIXTURE (EXISTING)	---
	WALL WASH FIXTURE	SEE FIXTURE SCHEDULE
	TRACK FIXTURE	SEE FIXTURE SCHEDULE
	EXHAUST FAN / LIGHT COMBO	SEE FIXTURE SCHEDULE
	EXHAUST FAN	SEE FIXTURE SCHEDULE
	HIGH BAY FIXTURE (ROUND)	SEE FIXTURE SCHEDULE
	HIGH BAY FIXTURE (RECTANGLE)	SEE FIXTURE SCHEDULE
	CEILING FAN	SEE FIXTURE SCHEDULE
	HANGING FIXTURE (CHANDELIER)	SEE FIXTURE SCHEDULE

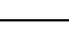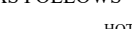


EXTERIOR LUMINAIRES		
SYMBOL	DESCRIPTION	MOUNTING
	POLE MOUNTED LIGHT FIXTURE	SEE FIXTURE SCHEDULE
	WALL PACK FIXTURE	SEE FIXTURE SCHEDULE
	BOLLARD / PATHWAY FIXTURE	SEE FIXTURE SCHEDULE
	WALL MOUNTED FIXTURE	SEE FIXTURE SCHEDULE




POWER DISTRIBUTION		
SYMBOL	DESCRIPTION	MOUNTING
	METER	AS NOTED
	PANELBOARD, 120/208V OR 120/240V	SEE PANEL SCHEDULE
	PANELBOARD, 277/480V	SEE PANEL SCHEDULE
	TRANSFORMER	AS NOTED
	DISCONNECT SWITCH	AS NOTED
	FUSED DISCONNECT SWITCH. (SIZE / FUSE / # OF POLES)	AS NOTED
	ENCLOSED CIRCUIT BREAKER.	AS NOTED
	DISCONNECT SWITCH WITH MOTOR STARTER.	AS NOTED
	MOTOR STARTER.	AS NOTED
	MOTOR STARTER SWITCH WITH OVERLOAD RELAYS AS REQUIRED.	AS NOTED
	MOTOR.	AS NOTED

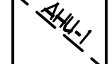	ELECTRIC DUCT HEATER.	AS NOTED
	POWER POLE	AS NOTED
	AUTOMATIC TRANSFER SWITCH.	AS NOTED
	MANUAL TRANSFER SWITCH.	AS NOTED
	JUNCTION BOX OR 4 SQUARE BOX.	AS NOTED

CONDUIT / WIRING AND GROUNDING		
SYMBOL	DESCRIPTION	MOUNTING
	DRIVEN ROD (UNLESS NOTED OTHERWISE)	---
	CONDUIT CONCEALED IN CEILING SPACE OR WALL	NUMBER OF WIRES INDICATED AS FOLLOWS
		TWO WIRES 
	HOME RUN TO PANEL (HASH MARKS INDICATE NUMBER OF WIRES)	THREE WIRES 
	CONDUIT RUN EXPOSED	FOUR WIRES 
	CONDUIT RUN EXPOSED	---
	LOW VOLTAGE WIRING	---
	CONDUIT RUN UP	AS SHOWN
	CONDUIT RUN DOWN	AS SHOWN

MECHANICAL UNITS		
SYMBOL	DESCRIPTION	MOUNTING
	AIR HANDLER	AS NOTED
	CONDENSING UNIT	AS NOTED
	RECIRCULATING PUMP	AS SHOWN
	INSTA-HOT WATER HEATER	AS SHOWN

	ELECTRICAL DEVICES TO BE REMOVED OR RELOCATED
	ELECTRICAL DEVICES TO REMAIN
	NEW ELECTRICAL DEVICES

   REFERS TO LIKE NUMBER KEY NOTES

NOTE:
ALL ITEMS IN LEGEND MAY NOT NECESSARILY APPEAR ON THE PLANS.

ABBREVIATIONS

AFB	- AVAILABLE FAULT CURRENT
AFB	- ABOVE FINISHED FLOOR
AHU	- AIR HANDLING UNIT
BFG	- BELOW FINISHED GRADE
CW	- CONDUIT
CW	- COOL WHITE
CU	- CONDENSING UNIT
CKT	- CIRCUIT
DACP	- DOOR ALARM CONTROL PANEL
DN	- DOWN
EF	- EXHAUST FAN
EG	- EQUIPMENT GROUND
ENCL	- ENCLOSURE
EW	- ELECTRIC WATER COOLER
EW	- ELECTRIC WATER HEATER
ETR	- EXISTING TO REMAIN
PNL	- PANEL
EOP	- EDGE OF PAVEMENT
EXP	- EXPLOSION PROOF
FCU	- FAN COIL UNIT
FHP	- FRACTIONAL HORSE POWER
FLA	- FULL LOAD AMPERES
G	- GROUND
GFI	- GROUND FAULT INTERRUPTER
HID	- HIGH INTENSITY DISCHARGE
HORIZ	- HORIZONTAL
IG	- ISOLATED GROUND
LW	- LIGHT WHITE
HP	- HORSEPOWER / HEAT PUMP
HVAC	- HEATING / VENTILATING, AIR CONDITIONING
JB	- JUNCTION BOX
LRA	- LOCKED ROTOR AMPERES
MCB	- MAIN CIRCUIT BREAKER
ML	- MAIN LUGS ONLY
N	- NEUTRAL
NL	- NIGHT LIGHT
OB	- OUTLET BOX
PB	- PULL BOX, PUSHBUTTON
PS	- PAY STATION
RECEPT	- RECEPTACLE
SF	- SUPPLY FAN
SPEC	- SPECIFICATIONS
SPD	- SURGE PROTECTION DEVICE
SWES	- SMOKE WARNING EMERGENCY CALL SYSTEM
TL	- TWISTLOCK
TTB	- TELEPHONE TERMINAL BOARD
TVTB	- TELEVISION TERMINAL BOARD
VERT	- VERTICAL
WM	- WATT METER
WP	- WEATHERPROOF
WW	- WARM WHITE
XFMR	- TRANSFORMER

GENERAL NOTES

4. ALL WORK IS TO COMPLY WITH THE 2020 NATIONAL ELECTRIC CODE AND THE 8TH EDITION, 2023 FLORIDA BUILDING CODE, AND ALL LOCAL CODES OR REGULATIONS THAT MAY APPLY TO THE PROJECT.
5. THE ELECTRICAL CONTRACTOR IS RESPONSIBLE FOR MAKING A SITE VISIT IN ORDER TO IDENTIFY EXISTING CONDITIONS. IT IS THE RESPONSIBILITY OF THE CONTRACTOR TO VERIFY THAT ANY ELECTRICAL SYSTEMS TO REMAIN ARE CODE COMPLIANT.
6. THE ELECTRICAL CONTRACTOR IS RESPONSIBLE FOR PROVIDING TEMPORARY POWER AND TEMPORARY LIGHTING AS REQUIRED FOR THE DURATION OF THE PROJECT.
7. THE ELECTRICAL CONTRACTOR IS REQUIRED TO PROVIDE A WORKMANSHIP WARRANTY OVER THE PERIOD OF ONE YEAR AFTER PROJECT COMPLETION THAT IS SUFFICIENT TO COMPLY WITH THE PROJECT CONTRACT.
8. THE ELECTRICAL CONTRACTOR IS TO PROVIDE A COMPLETE SET OF MARKED UP ELECTRICAL "AS BUILT" DRAWINGS TO THE GENERAL CONTRACTOR UPON COMPLETION OF THE PROJECT.
9. THE ELECTRICAL CONTRACTOR IS TO PROVIDE AN OPERATION AND MAINTENANCE MANUAL FOR ALL EQUIPMENT REQUIRING MAINTENANCE ASSOCIATED WITH THE PROJECT.
10. THE ELECTRICAL CONTRACTOR IS RESPONSIBLE FOR COORDINATING ALL WORK WITH OTHER TRADES IN ORDER TO NOT INTERFERE WITH THE OVERALL PROJECT SCHEDULE.
11. IF A DISCREPANCY IS FOUND BETWEEN THE ELECTRICAL PLANS AND THE SPECIFICATIONS, THE MOST STRINGENT REQUIREMENT SHALL GOVERN UNLESS WRITTEN APPROVAL IS GRANTED FROM THE ARCHITECT OR ENGINEER.

SUBMITTALS AND SHOP DRAWINGS

1. PRIOR TO PROCUREMENT, THE CONTRACTOR IS REQUIRED TO PROVIDE SUBMITTALS AND SHOP DRAWINGS TO THE GENERAL CONTRACTOR, ENGINEER, AND ARCHITECT FOR APPROVALS.
2. IT IS THE RESPONSIBILITY OF THE ELECTRICAL CONTRACTOR TO ENSURE THE SUBMITTED PRODUCTS WILL FORM A COMPLETE, FUNCTIONAL, AND CODE COMPLIANT ELECTRICAL SYSTEM.

WIRING AND RACEWAYS

3. NO WIRING IS TO BE SMALLER THAN #12 AWG UNLESS OTHERWISE NOTED.
2. EACH BRANCH CIRCUIT FOR LIGHTING AND RECEPTACLES SHALL BE INSTALLED WITH DEDICATED NEUTRAL. ALL OTHER CIRCUITS SHALL BE INSTALLED WITH DEDICATED NEUTRAL UNLESS EQUIPMENT DOES NOT REQUIRE A NEUTRAL CONNECTION.
3. THE CONDUCTORS FOR FEEDERS AND BRANCH CIRCUITS COMBINED SHALL BE SIZED FOR A MAXIMUM AT 5% VOLTAGE DROP TOTAL PER FBC C405.5.3.
4. TYPE MC CABLING IS ACCEPTABLE UNLESS PROHIBITED BY THE SPECIFICATIONS OF THE PROJECT, OR THE NATIONAL ELECTRIC CODE DUE TO THE OCCUPANCY TYPE OF THE PROJECT.
5. NONMETALLIC CABLING (ROMEX) SHALL NOT BE USED.
6. ALL WIRING IS TO BE SIZED PER NEC.
7. IT IS THE RESPONSIBILITY OF THE ELECTRICAL CONTRACTOR TO UPSIZE ALL CONDUIT AND WIRING WHEN REQUIRED DUE TO VOLTAGE DROP POSED BY ONSITE CONDITIONS.
8. PROVIDE COMPLETE RACEWAYS FOR ALL SYSTEMS AS REQUIRED BY THE NEC AND LOCAL CODES. TYPE PVC, EMT, AND RMC ARE PERMITTED AS REQUIRED BY THE LOCAL CODE.
9. A GROUND CONDUCTOR IS TO BE SUPPLIED IN ALL RACEWAYS. SIZE THE GROUND CONDUCTOR PER THE NEC, OR AS SHOWN ON THE PLAN, WHICHEVER IS LARGER.
10. RACEWAYS ARE TO BE CONCEALED AND EQUIPMENT IS TO BE FLUSH MOUNTED, UNLESS OTHERWISE NOTED, OR WHEN ONSITE CONDITIONS MAKE CONCEALING OR FLUSH MOUNTING IMPOSSIBLE.
11. WHEN A RACEWAY PENETRATES A FIRE WALL OR FLOOR, THE RACEWAY IS TO BE SEALED IN A MANNER WHICH WILL MAINTAIN THE RATING OF THE WALL OR FLOOR.
12. MINIMUM CONDUIT SIZE IS TO BE 3/4 INCH, UNLESS OTHERWISE NOTED.
13. FLEXIBLE CONDUIT IS ALLOWABLE IN LENGTHS OF 6' OR LESS, WHEN IT IS MORE PRACTICAL TO MAKE CONNECTIONS TO EQUIPMENT.
14. SEALTITE FLEXIBLE CONDUIT IS TO BE USED IN OUTDOOR APPLICATIONS.
15. THE RACEWAY SYSTEM AS A WHOLE IS REQUIRED TO COMPLY WITH ALL NEC AND LOCAL CODE REQUIREMENTS.

GROUNDING

1. THE ELECTRICAL SYSTEM IS TO BE GROUNDED IN ITS ENTIRETY PER THE NEC.
2. THE TELEPHONE / NETWORK BOARD IS TO HAVE NO. 6 AWG GROUND WIRE TO THE MAIN SERVICE GROUND.
3. ALL METALLIC EQUIPMENT INCLUDING RACEWAYS, PANELBOARDS, DISCONNECTS, BOXES, ARE TO BE CONNECTED TO THE GROUNDING SYSTEM PER NEC REQUIREMENTS.
4. THE SERVICE GROUND IS TO BE SIZED ACCORDING TO NEC REQUIREMENTS AND IS TO BE CONNECTED TO BUILDING STEEL, COLD WATER PIPING, CONCRETE ENCASED STEEL, AND GAS PIPING IF REQUIRED.

DEVICES

1. LIGHT SWITCHES ARE TO BE MOUNTED 48 INCHES ABOVE FINISHED FLOOR TO THE TOP OF THE DEVICE, UNLESS OTHERWISE NOTED.
2. RECEPTACLES ARE TO BE MOUNTED 18 INCHES ABOVE FINISHED FLOOR TO THE CENTERLINE OF THE DEVICE, UNLESS OTHERWISE NOTED.
3. THE COLOR AND STYLE OF OUTLETS AND SWITCHES ARE TO BE DETERMINED BY THE CLIENT.
4. RECEPTACLES ARE TO BE GFCI TYPE WHERE NOTED.
5. PROVIDE TAMPER-RESISTANT RECEPTACLES IN OCCUPANCIES WHERE REQUIRED BY NEC 2020, 406.12.
6. RECEPTACLES AND SWITCHES ARE TO BE FLUSH MOUNTED UNLESS OTHERWISE NOTED.
7. IT IS THE RESPONSIBILITY OF THE ELECTRICAL CONTRACTOR TO ENSURE COMPATIBILITY OF SPECIAL RECEPTACLES WITH THE EQUIPMENT THEY ARE INTENDED TO SERVE.
8. ALL EXTERIOR RECEPTACLES AND RECEPTACLES SUBJECT TO MOISTURE MUST BE OF GFCI TYPE REGARDLESS OF THE TYPE SHOWN ON THE ELECTRICAL PLANS.
9. ALL EXTERIOR RECEPTACLES AND SWITCHES ARE REQUIRED TO BE INSTALLED WITH WEATHERPROOF "IN USE" TYPE COVERS.
10. DEVICES ARE SHOWN ON THE ELECTRICAL PLANS FOR A REFERENCE LOCATION ONLY. COORDINATE EXACT LOCATION WITH ARCHITECTURAL PLANS AND OTHER TRADES. NOTE ANY CHANGES ON THE "AS BUILT" SET OF ELECTRICAL PLANS.

SWITCHGEAR

- PANELBOARDS AND LOAD CENTERS ARE TO BE SQUARE D OR APPROVED EQUAL.
2. PANELBOARDS AND LOAD CENTERS ARE TO BE PROVIDED WITH TRANSIENT VOLTAGE SURGE SUPPRESSION AS DESCRIBED IN THE ELECTRICAL PLANS.
3. DISCONNECTS ARE TO BE HEAVY DUTY TYPE AND ARE TO BE FUSED WHERE THE EQUIPMENT IS NOT SUPPLIED BY THE APPROPRIATE BREAKER.
4. ALL NEW BREAKERS ADDED TO EXISTING PANELS ARE TO MATCH THE EXISTING PANEL MANUFACTURER AND AIC RATING OF THE EXISTING BREAKERS.
5. THE LOCATIONS OF ALL SWITCHGEAR, PANELS, DISCONNECTS, MCC'S, ETC. IS APPROXIMATE. CONSULT OWNER PRIOR TO ROUGH IN OF EQUIPMENT.
6. PROVIDE TYPED PANEL SCHEDULES/DIRECTORIES FOR ALL PANELS UPON COMPLETION OF THE PROJECT. ENSURE THAT THE SCHEDULES PROVIDED REFLECT THE "AS BUILT" CONDITION AND ARE NOT SIMPLY COPIES OF THE PANEL SCHEDULES FROM THESE PLANS. IF AN EXISTING PANEL IS MODIFIED, IT IS ACCEPTABLE TO ADD THE MODIFICATION TO THE EXISTING SCHEDULE IN THE MANNER THE EXISTING SCHEDULE WAS ORIGINALLY CREATED.
7. PROVIDE ENGRAVED PLASTIC LAMINATE NAME TAGS ON THE FRONT OF ALL PANELS, DISCONNECTS, TRANSFORMERS AND OTHER SWITCHGEAR. LABEL THE EQUIPMENT TO MATCH THE AS BUILT DRAWINGS TO ENSURE MAINTENANCE PERSONNEL ARE PROVIDED THE INFORMATION THEY NEED TO QUICKLY IDENTIFY THE ELECTRICAL SYSTEM.
8. PROVIDE ALL OTHER IDENTIFICATION AS REQUIRED PER ANSL, NEC, AND ANY OTHER APPLICABLE STANDARDS / SPECIFICATIONS.
9. IT IS THE RESPONSIBILITY OF THE ELECTRICAL CONTRACTOR TO VERIFY ALL NEC CLEARANCE REQUIREMENTS ARE MET BEFORE THE ROUGH-IN OF ANY EQUIPMENT. THE LAYOUT OF SWITCHGEAR AND OTHER EQUIPMENT ON THE PLANS IS DIAGRAMMATICAL ONLY.
10. IT IS THE SOLE RESPONSIBILITY OF THE ELECTRICAL CONTRACTOR TO ENSURE THE METERING SCHEME SHOWN ON THESE PLANS CONFORM TO THE SPECIFICATIONS OF THE LOCAL UTILITY COMPANY GOVERNING THIS PROJECT. THE LOCAL UTILITY'S METERING STANDARDS BOOK NEEDS TO BE RESEARCHED BY THE ELECTRICAL CONTRACTOR PRIOR TO ORDERING OF MATERIALS.
11. IT IS THE SOLE RESPONSIBILITY OF THE CONTRACTOR TO VERIFY THE AVAILABLE FAULT CURRENT CALCULATIONS ON THIS PLAN SET. CALCULATIONS WITHIN THIS PLAN SET ARE BASED ON TRANSFORMER AND CONDUCTOR INFORMATION THAT MAY OR MAY NOT REFLECT THE ACTUAL INSTALLATION ON THE PROJECT SITE. ANY DISCREPANCIES INCLUDING THE AVAILABLE FAULT CURRENT AT UTILITY TRANSFORMERS MUST BE BROUGHT TO THE ENGINEER'S ATTENTION PRIOR TO ORDERING ANY EQUIPMENT.

LIGHTING


1. CONNECT ALL EXIT SIGNS, EGRESS FIXTURES, AND NIGHT LIGHTS ON THE UNSWITCHED LEG OF A LOCAL LIGHTING CIRCUIT.
2. MINIMUM EMERGENCY ILLUMINATION OF 1 FOOT CANDLE AT FLOOR LEVEL ALONG THE PATH OF EGRESS FOR 90 MINUTES IS REQUIRED. EMERGENCY LIGHTING FIXTURES SHALL BE ARRANGED BY THE CONTRACTOR TO ACCOMPLISH THIS REQUIREMENT.
3. REFER TO THE ARCHITECTURAL CEILING PLAN FOR EXACT FIXTURE LOCATIONS.
4. MULTIPLE FIXTURES MAY HAVE OPTIONS FOR MOUNTING IN GRID, OR DRYWALL CEILINGS. IT IS THE RESPONSIBILITY OF THE CONTRACTOR TO ENSURE THE PROPER MOUNTING HARDWARE AND TRIM PIECES ARE ORDERED BASED ON THE CEILING TYPES SHOWN IN THE ARCHITECTURAL PLANS.
5. ALL FIXTURES AND CONTROLS ARE FURNISHED AND INSTALLED BY THE ELECTRICAL CONTRACTOR, UNLESS OTHERWISE NOTED.

PROFESSIONAL STATEMENT

TO THE BEST OF THE ENGINEER'S KNOWLEDGE, THE PLANS AND SPECIFICATIONS COMPLY WITH THE APPLICABLE MINIMUM BUILDING CODES AND THE APPLICABLE FIRE SAFETY STANDARDS AS DETERMINED BY THE LOCAL AUTHORITY IN ACCORDANCE WITH FLORIDA STATUTES.

CURRENT APPLICABLE CODES

ALL WORK IS TO COMPLY WITH THE 2020 NATIONAL ELECTRIC CODE AND THE 8TH EDITION, 2023 FLORIDA BUILDING CODE, AND ALL LOCAL CODES OR REGULATIONS THAT MAY APPLY TO THE PROJECT.

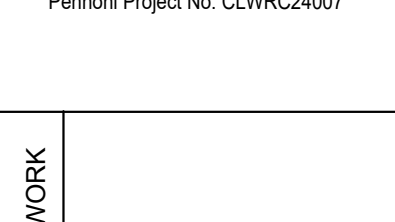

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James Vincent Barnes II, P.E.
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 Pennoni Project No. CLWRC24007


ALL DIMENSIONS MUST BE VERIFIED BY CONTRACTOR AND OWNER MUST BE NOTIFIED OF ANY DISCREPANCIES BEFORE PROCEEDING WITH WORK

**ROSS NORTON RECREATION
 CENTER POOL BUILDING - PHASE 2**


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PROJECT	CLWRC24007				
DATE	10/21/24				
DRAWING SCALE	AS NOTED				
DRAWN BY	KTK				
APPROVED BY	CAG				

E0.0

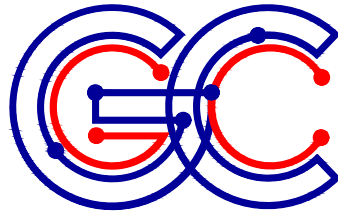

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FILL MATERIAL IDENTIFICATION	MIN. THK OF FILL MATERIAL, in.
TYPE FB-2001	1
TYPE FB-2000 OR FB-2003	1/2

MINNESOTA MINING & MFG Co. - TYPES FB-2000, FB-2000+, FB-2001, FB-2003 (FLOORS ONLY). (NOTE: L RATINGS APPLY ONLY WHEN FB-2000 IS USED.)
* BEARING THE UL CLASSIFICATION MARKING

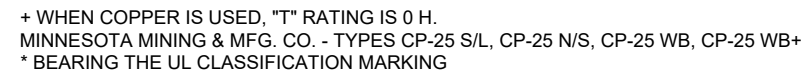NOTES:

- a. LABEL DISTRIBUTION EQUIPMENT SUCH AS PANELBOARDS, SWITCHBOARDS, DISCONNECTS, TRANSFORMERS, ETC. SHALL BE PROVIDED WITH AN EQUIPMENT LABEL PER THE REQUIREMENTS OF THIS DETAIL.
- a. LABELS SHALL BE 2-PLY ENGRAVED PLASTIC LAMINATE WITH BLACK TYPEFACE LETTERS. LABEL BACKGROUND SHALL FOLLOW THE BELOW COLOR SCHEME:
 - a. NORMAL POWER - WHITE
 - b. UPS POWER - BLUE
 - c. LIFE SAFETY POWER - YELLOW
- a. LABEL MATERIAL SHALL BE DURABLE, UV STABLE, RATED FOR OUTDOOR USE, AND ABRASION RESISTANT. WHERE ATTACHED TO NEMA 4X EQUIPMENT, LABELS SHALL IN ADDITION BE CHEMICAL RESISTANT.
- a. LABELS SHALL BE 1/2" HIGH AND 1 1/2" WIDE. LABELS SHALL BE ENCLOSED UNLESS DONE SO COMPROMISE ITS NEMA / IP RATING. LABELS FOR ENCLOSURES WITH WELDED SEAMS AND GASKETED DOORS SUCH AS THOSE RATED NEMA 12 OR NEMA 4 SHALL BE 1/4" HIGH AND 1 1/2" WIDE. LABELS SHALL BE 1/4" THICK AND HAVE DOUBLE-SIDED MOUNTING TAPES.
- a. A SUBMITTAL WITH A COMPLETE LIST OF EQUIPMENT LABELS SHALL BE PROVIDED FOR ENGINEER APPROVAL PRIOR TO ORDERING.
- a. LABELS SHALL INDICATE NO LESS THAN THE FOLLOWING:
 - a. EQUIPMENT NAME
 - b. THE NOMINAL SYSTEM VOLTAGE WHICH SAID EQUIPMENT IS CONNECTED TO
 - c. THE EQUIPMENT NAME SUPPLYING POWER TO SAID EQUIPMENT
 - d. THE AVAILABLE FAULT CURRENT AT SAID EQUIPMENT

NOTES:

PROVIDE ARC FLASH HAZARD LABELING AND FIELD MARK ALL ELECTRICAL EQUIPMENT AS PART OF ARC FLASH RISK ASSESSMENT PER 2015 EDITION OF NFPA 70E 130.5(D). THE LABEL MUST CONTAIN THE FOLLOWING INFORMATION:


1. KNOWN SYSTEM VOLTAGE.
2. ARC FLASH BOUNDARY.
3. AT LEAST ONE OF THE FOLLOWING:
 - a. AVAILABLE INCIDENT ENERGY AND THE CORRESPONDING DISTANCE, OR THE ARC FLASH PPE CATEGORY IN TABLE 130.7(C)(15)(A)(i) OR 130.7(C)(15)(B) FOR THE EQUIPMENT, BUT NOT BOTH.
 - b. MINIMUM ARC RATING OF CLOTHING.
 - c. SITE-SPECIFIC LEVEL OF PPE.

NOTES:


1. MOUNTING HEIGHTS SHOWN ARE FROM FINISHED FLOOR (A.F.F.), UNLESS OTHERWISE NOTED
2. LOCATIONS OF OUTLETS SHOWN ON ARCHITECTURAL ELEVATIONS SHALL TAKE PRECEDENCE OVER THESE MOUNTING HEIGHTS. FIELD LOCATE OUTLETS WITH ARCHITECT DURING ROUGH-IN.
3. INSTALL OUTLETS THAT ARE IN CLOSE PROXIMITY ON THE SAME CENTERLINE. OUTLETS THAT ARE IN CLOSE PROXIMITY ON DIFFERENT CENTERLINES SHALL BE SPACED TO MAINTAIN THE SAME HORIZONTAL CENTERLINE LOCATED HALF WAY BETWEEN THE HEIGHTS SHOWN. OUTLETS THAT ARE MORE THAN 1'-0" APART VERTICALLY SHALL BE INSTALLED ON THE SAME VERTICAL CENTERLINE.
4. VERIFY MOUNTING HEIGHTS WITH LOCAL AUTHORITY.
5. I/A REQUIREMENTS SHALL SUPERCEDE STANDARD MOUNTING WHEN THERE IS A CONFLICT.

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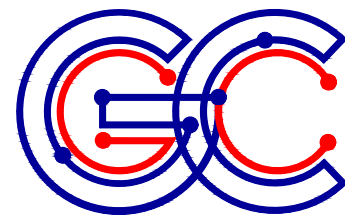
C:\Gulf Coast Electrical Design\200_Design Projects_Owner\24-000-0115_Solar Motor Equipment Bldg\Drawings\GCE\Electrical_Ross Norton Pool Equipment Bldg - Phase 2.dwg PLOTTED: 1/19/2024 2:23 PM BY: owner PROJECT STATUS: — PLOTTED: 1/19/2024 2:23 PM BY: owner PLOT STYLE: asc Standard.ctb

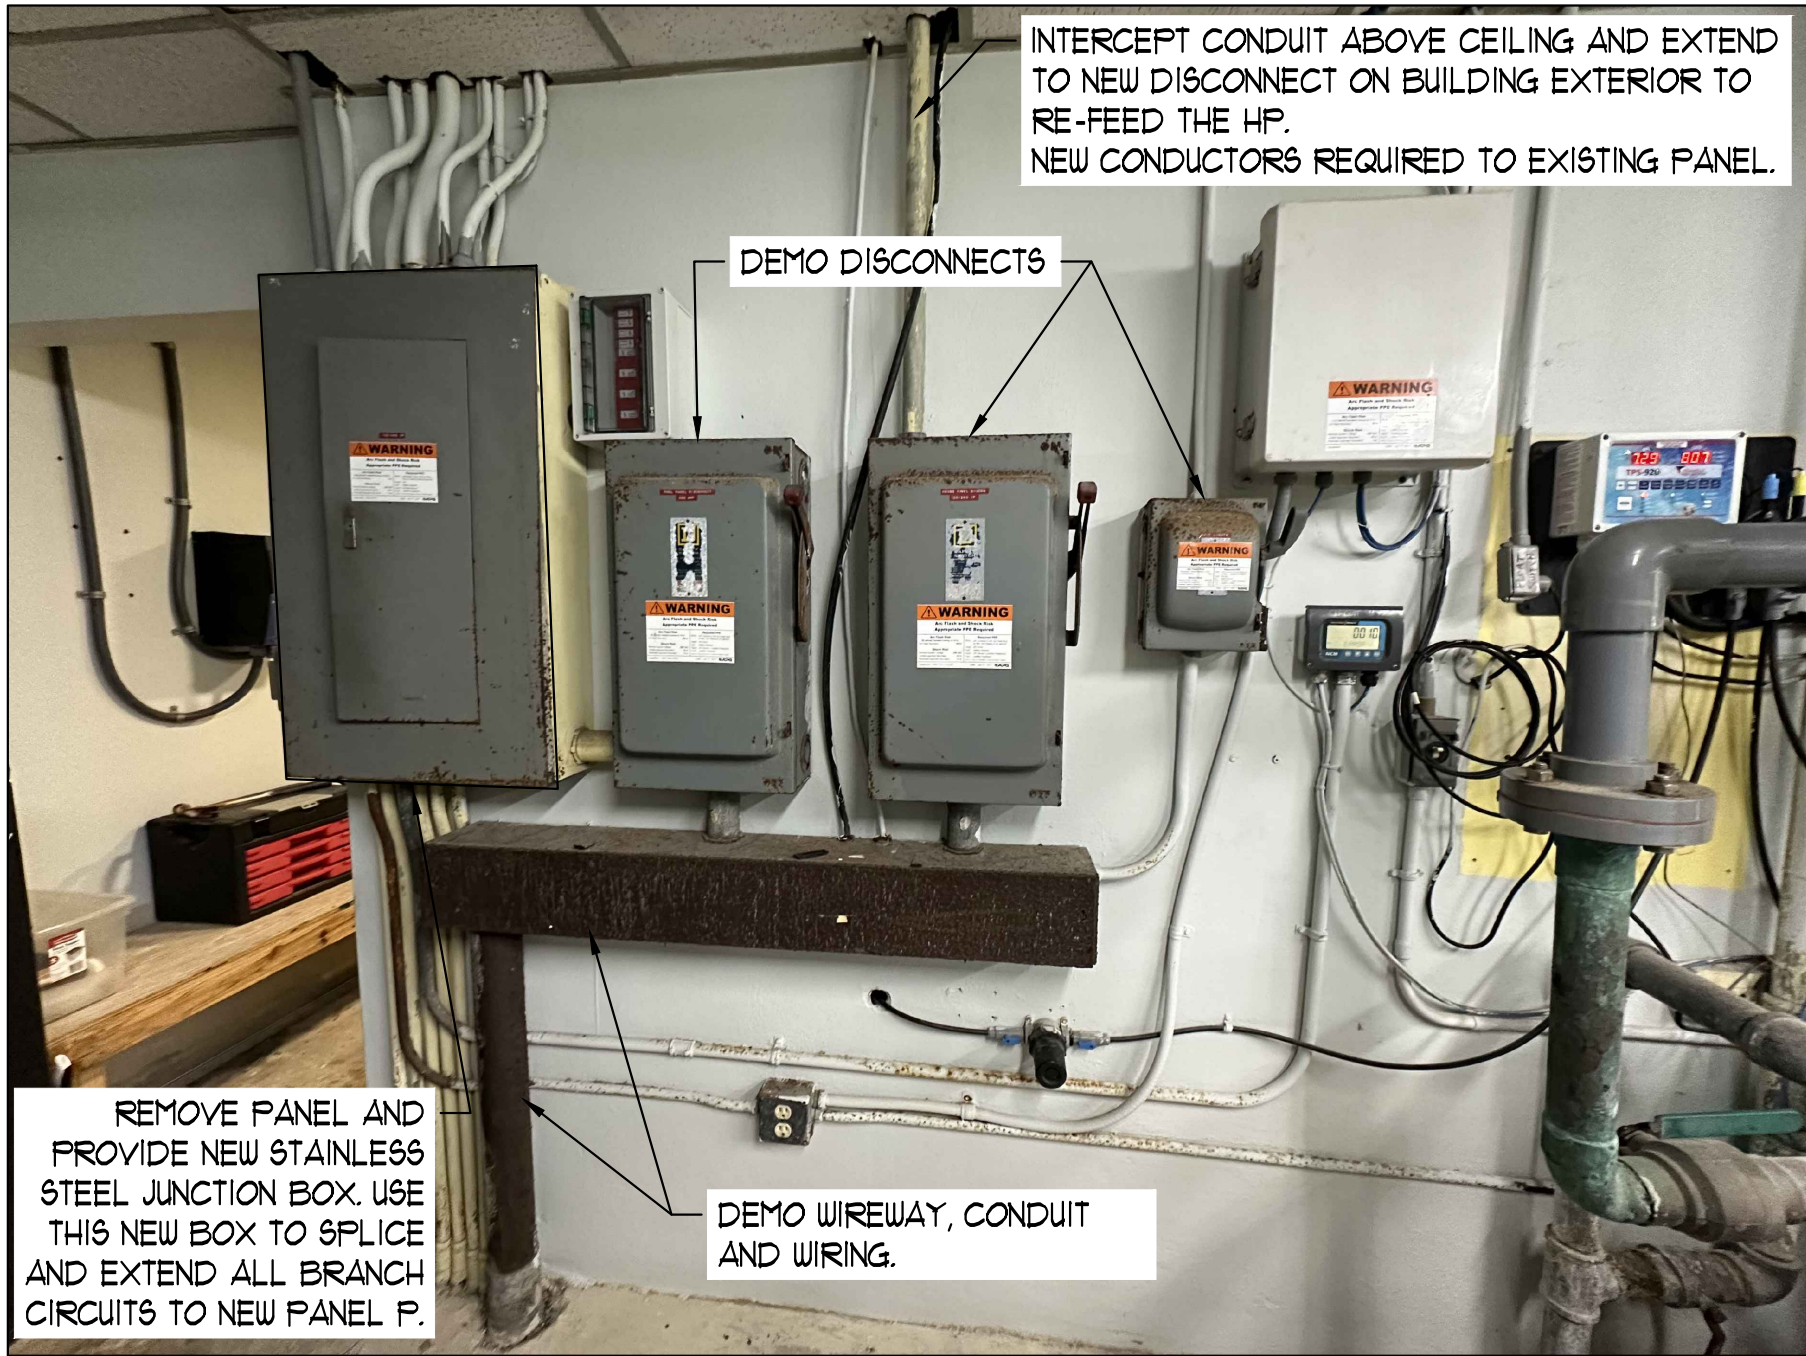

2 EXISTING ELEVATION
E1.0 SCALE: NONE

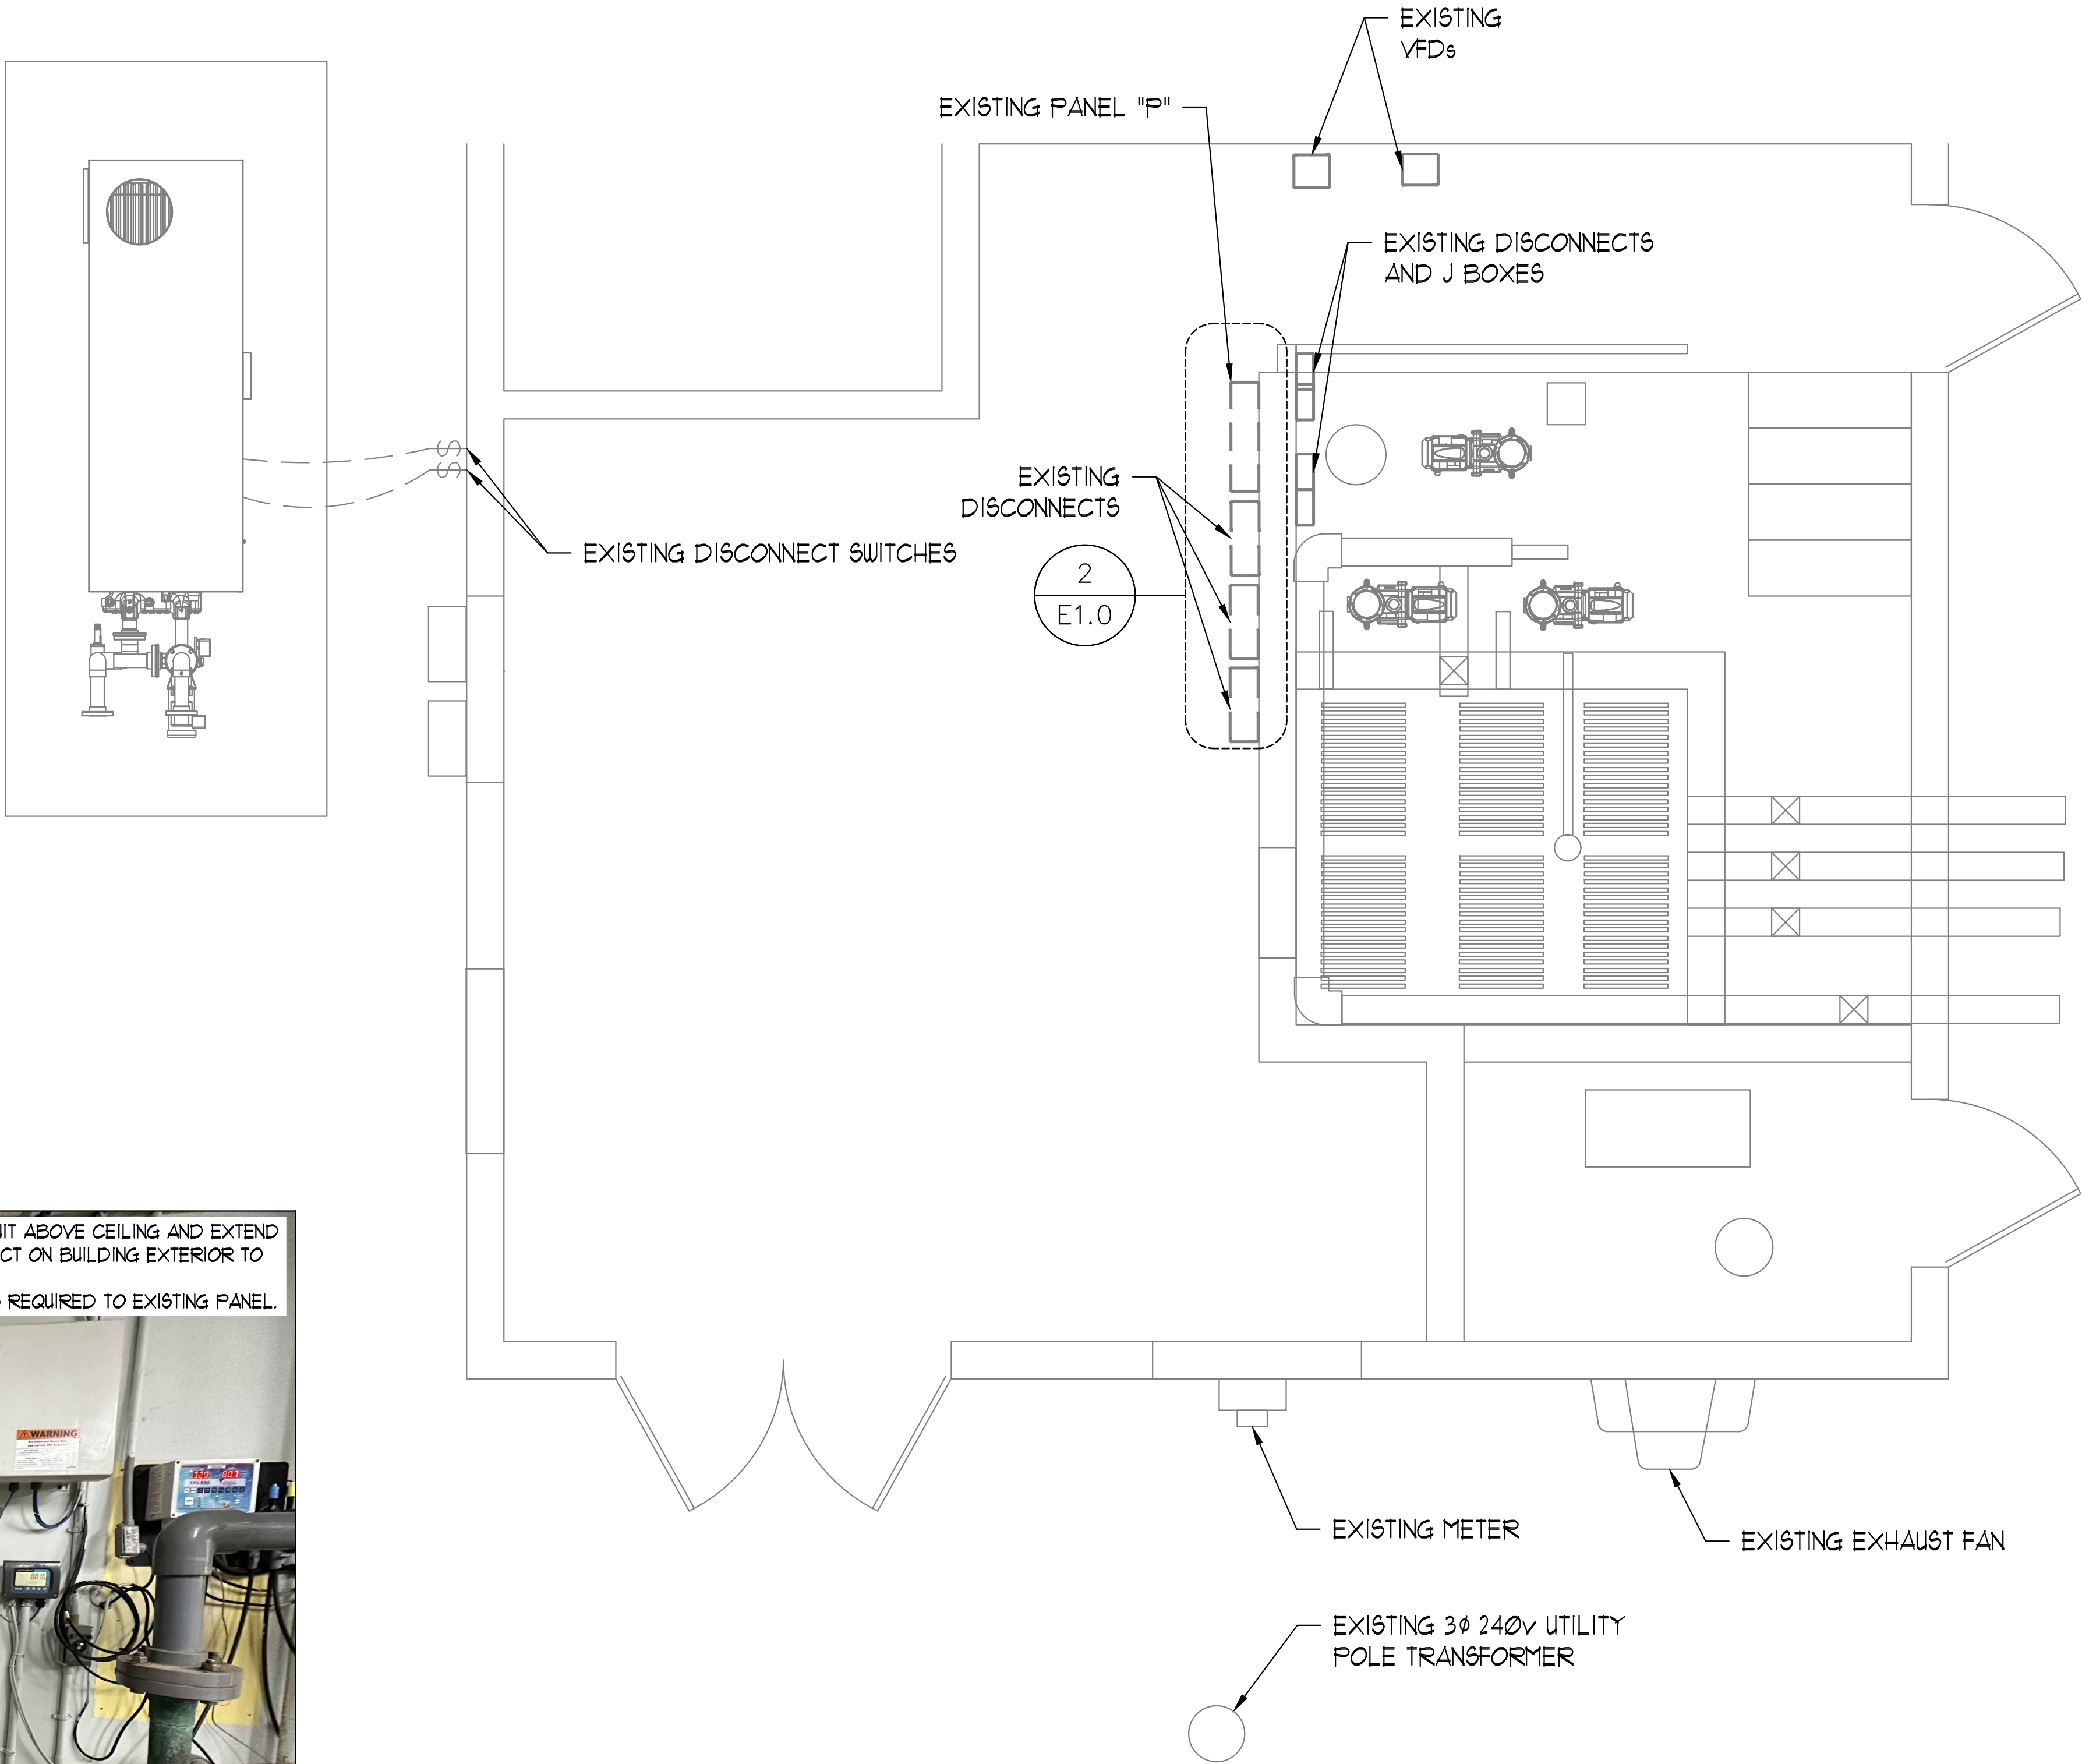

1 EXISTING POWER PLAN
E1.0 SCALE: 1/2" = 1'-0"



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Pennoni Project No. CLWRC24007

ALL DIMENSIONS MUST BE VERIFIED BY CONTRACTOR
AND OWNER MUST BE NOTIFIED OF ANY
DISCREPANCIES BEFORE PROCEEDING WITH WORK

ROSS NORTON RECREATION
CENTER POOL BUILDING - PHASE 2
1426 S. M.L.K. JR. AVE.
CLEARWATER, FL 33756

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PROJECT	CLWRC24007
DATE	10/21/24
DRAWING SCALE	AS NOTED
DRAWN BY	KTK
APPROVED BY	CAG

E1.0

PROJECT STATUS: ---
PLOT STYLE: asc Standard.dwg
PLOTTER: HP DesignJet 2530 PCL6
PLOT DATE: 11/26/2024 2:23 PM BY: owner
G:\Gulf Coast Electrical Design\2024 Design Projects - One-Off\24-036-1755_Ross Norton Recreation Building\GulfCoastElectrical_Ross Norton Pool Equipment Bldg - Phase 2.dwg

- NOTES:
- ELECTRICAL CONTRACTOR SHALL MAKE ALL FINAL CONNECTIONS TO EQUIPMENT.
 - ELECTRICAL CONTRACTOR SHALL VERIFY ALL EQUIPMENT REQUIREMENTS (INCLUDING THOSE SCHEDULED) WITH SUPPLIER PRIOR TO ROUGH-IN.

POWER KEYED NOTES:


- NEW NEMA3R JUNCTION BOX. EXTEND ALL EXISTING WIRING FROM NEW JUNCTION BOX TO NEW PANEL "A".
- COORDINATE LOCATION WITH GC/OWNER PRIOR TO ROUGH-IN. EC TO OFFER NEMA3R AND NEMA4X ENCLOSURE OPTIONS.
- NEW SPLICE BOX ABOVE CEILING FOR PANEL H FEEDERS.
- REPLACE EXISTING 30, 30A DISCONNECTS WITH NEW NEMA 3R.

CIRCUITING EXAMPLE KEY

CKT: A-3a
DENOTES PANEL NAME
DENOTES LIGHTING SWITCH LEG (BY ROOM) LIGHTING PLAN ONLY
DENOTES CIRCUIT NUMBER

DISCONNECT EXAMPLE KEY

3P/240/60/50/N3R
NUMBER OF POLES
VOLTAGE
AMPERAGE RATING
FUSE SIZE
NEMA WEATHER RATING
("NF" DENOTES NON-FUSED)

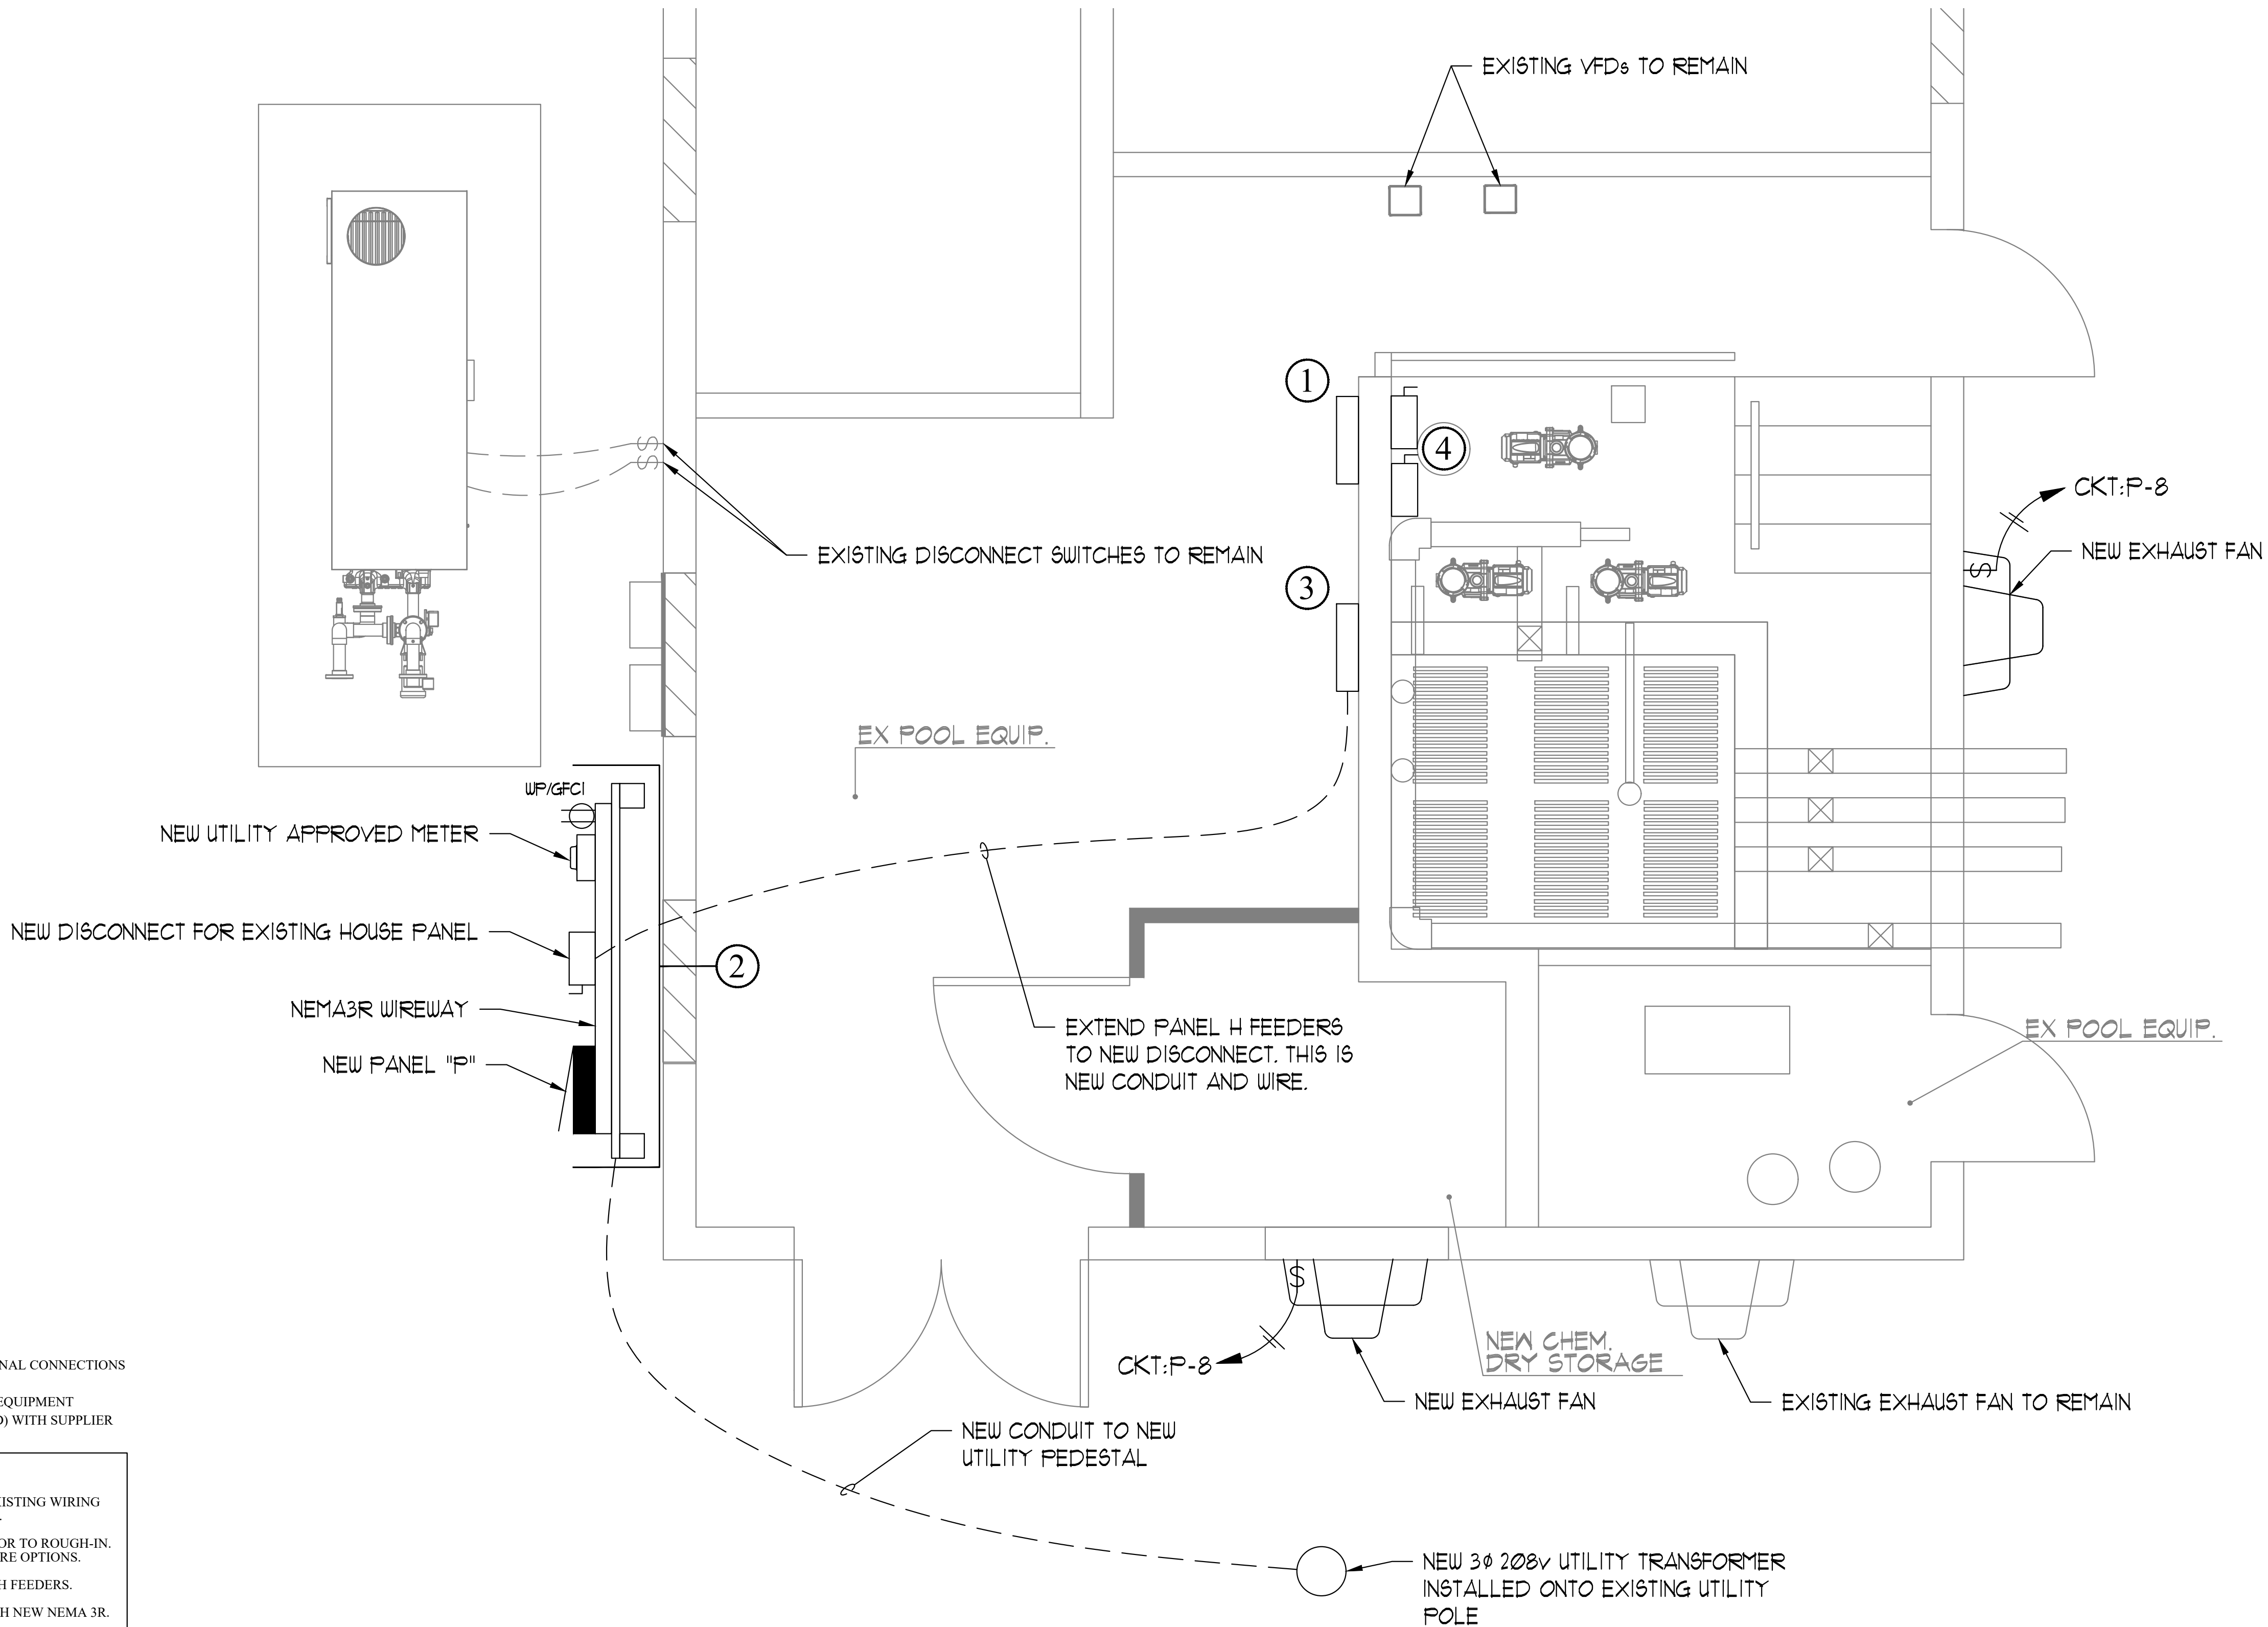

1
E2.0
PROPOSED POWER PLAN
SCALE: 1/2" = 1'-0"

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ALL DIMENSIONS MUST BE VERIFIED BY CONTRACTOR
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CENTER POOL BUILDING - PHASE 2
1426 S. M.L.K. JR. AVE.
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PROJECT	CLWRC24007
DATE	10/21/24
DRAWING SCALE	AS NOTED
DRAWN BY	KTK
APPROVED BY	CAG

E2.0

NEW RISER KEYED NOTES:

1. NEW UTILITY TRANSFORMER 120/208V, 3-PHASE.
2. NEW UTILITY APPROVED METER SOCKET.
3. NEW SERVICE WIREWAY, NEMA 3R.
4. NEW PANEL "P", 120/208V, 3-PHASE, 4-WIRE, 250A, MCB, NEMA 3R.
5. NEW SURGE PROTECTION DEVICE.
6. NEW 20A RECEPTACLE WITH WEATHERPROOF ENCLOSURE, CIRCUIT P-10.
7. NEW SERVICE RATED 3 POLE, 208V, 200A WITH 150A FUSES INSTALLED, NEMA 3R DISCONNECT.
8. NEW STAINLESS STEEL JUNCTION BOX.
9. EXISTING PANEL "HOUSE", 120/240V, 1-PHASE, 3-WIRE, 150A, MCB, NEMA 1.
10. NEW SPLICE BOX ABOVE CEILING FOR PANEL "HOUSE" FEEDERS

SERVICE ENTRANCE FEEDER SCHEDULE

CU400SE	400A SERVICE ENTRANCE FEEDER: 1 SET OF - (3) 600 MCM CU & (1) 600 MCM CU NEUTRAL IN 4" CONDUIT
CU250SE	250A SERVICE ENTRANCE FEEDER: 1 SET OF - (3) 250 MCM CU & (1) 250 MCM CU NEUTRAL IN 2 1/2" CONDUIT
10CU150SE	150A SERVICE ENTRANCE FEEDER: 1 SET OF - (2) 1/0 CU & (1) 1/0 CU NEUTRAL IN 1 1/2" CONDUIT


FEEDER SCHEDULE

10CU150	150A FEEDER: 1 SET OF - (2) 1/0 CU, (1) 1/0 CU NEUTRAL & (1) #6 CU E.G.C. IN 2" CONDUIT
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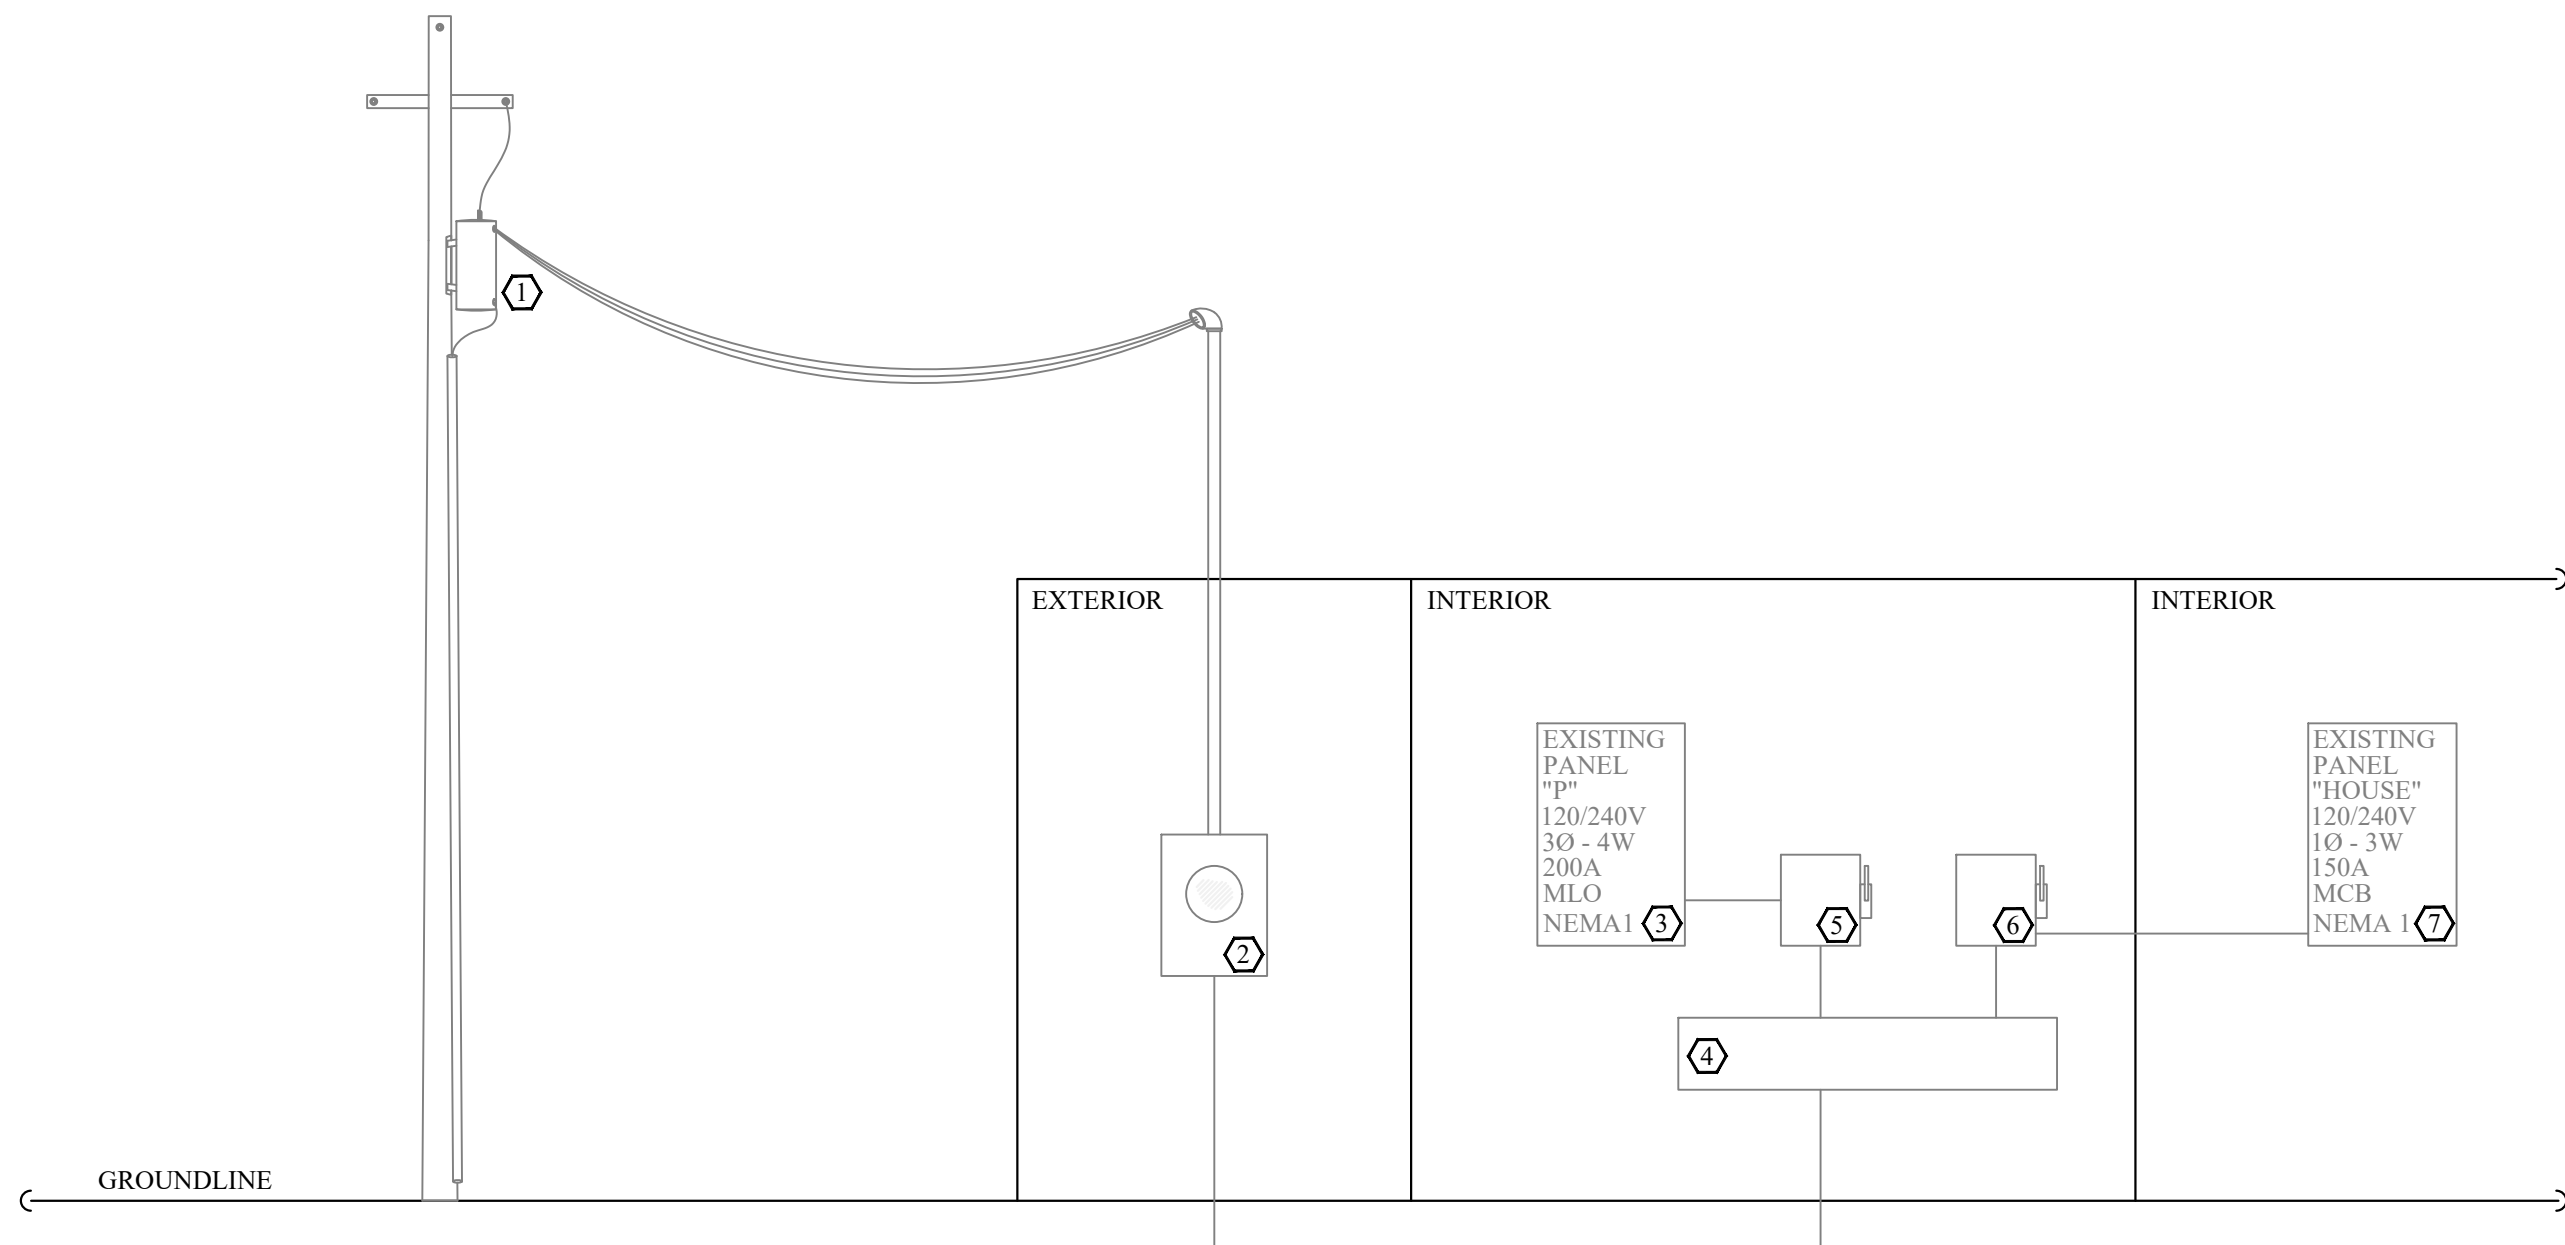
PANEL LABELING	
NEW OR EXISTING	DENOTES CONDITION
"A"	DENOTES NAME
277/480V	DENOTES VOLTAGE
3Ø, 4-WIRE	DENOTES PHASE, SYSTEM
200A	DENOTES AMPS
MCB OR MLO	DENOTES PANEL TYPE
NEMA	DENOTES ENCLOSURE RATING

EXISTING RISER KEYED NOTES:

1. EXISTING UTILITY TRANSFORMER 120/240V, 3-PHASE.
2. EXISTING UTILITY METER.
3. EXISTING PANEL "P", 120/240V, 3-PHASE, 4-WIRE, 200A, MLO, NEMA 1.
4. EXISTING WIREWAY, NEMA 1.
5. EXISTING 3-POLE, 240V, 200A WITH 200A FUSES INSTALLED, NEMA 1 DISCONNECT.
6. EXISTING 2-POLE, 240V, 200A WITH 150A FUSES INSTALLED, NEMA 1 DISCONNECT.
7. EXISTING PANEL "HOUSE", 120/240V, 1-PHASE, 3-WIRE, 150A, MCB, NEMA 1.

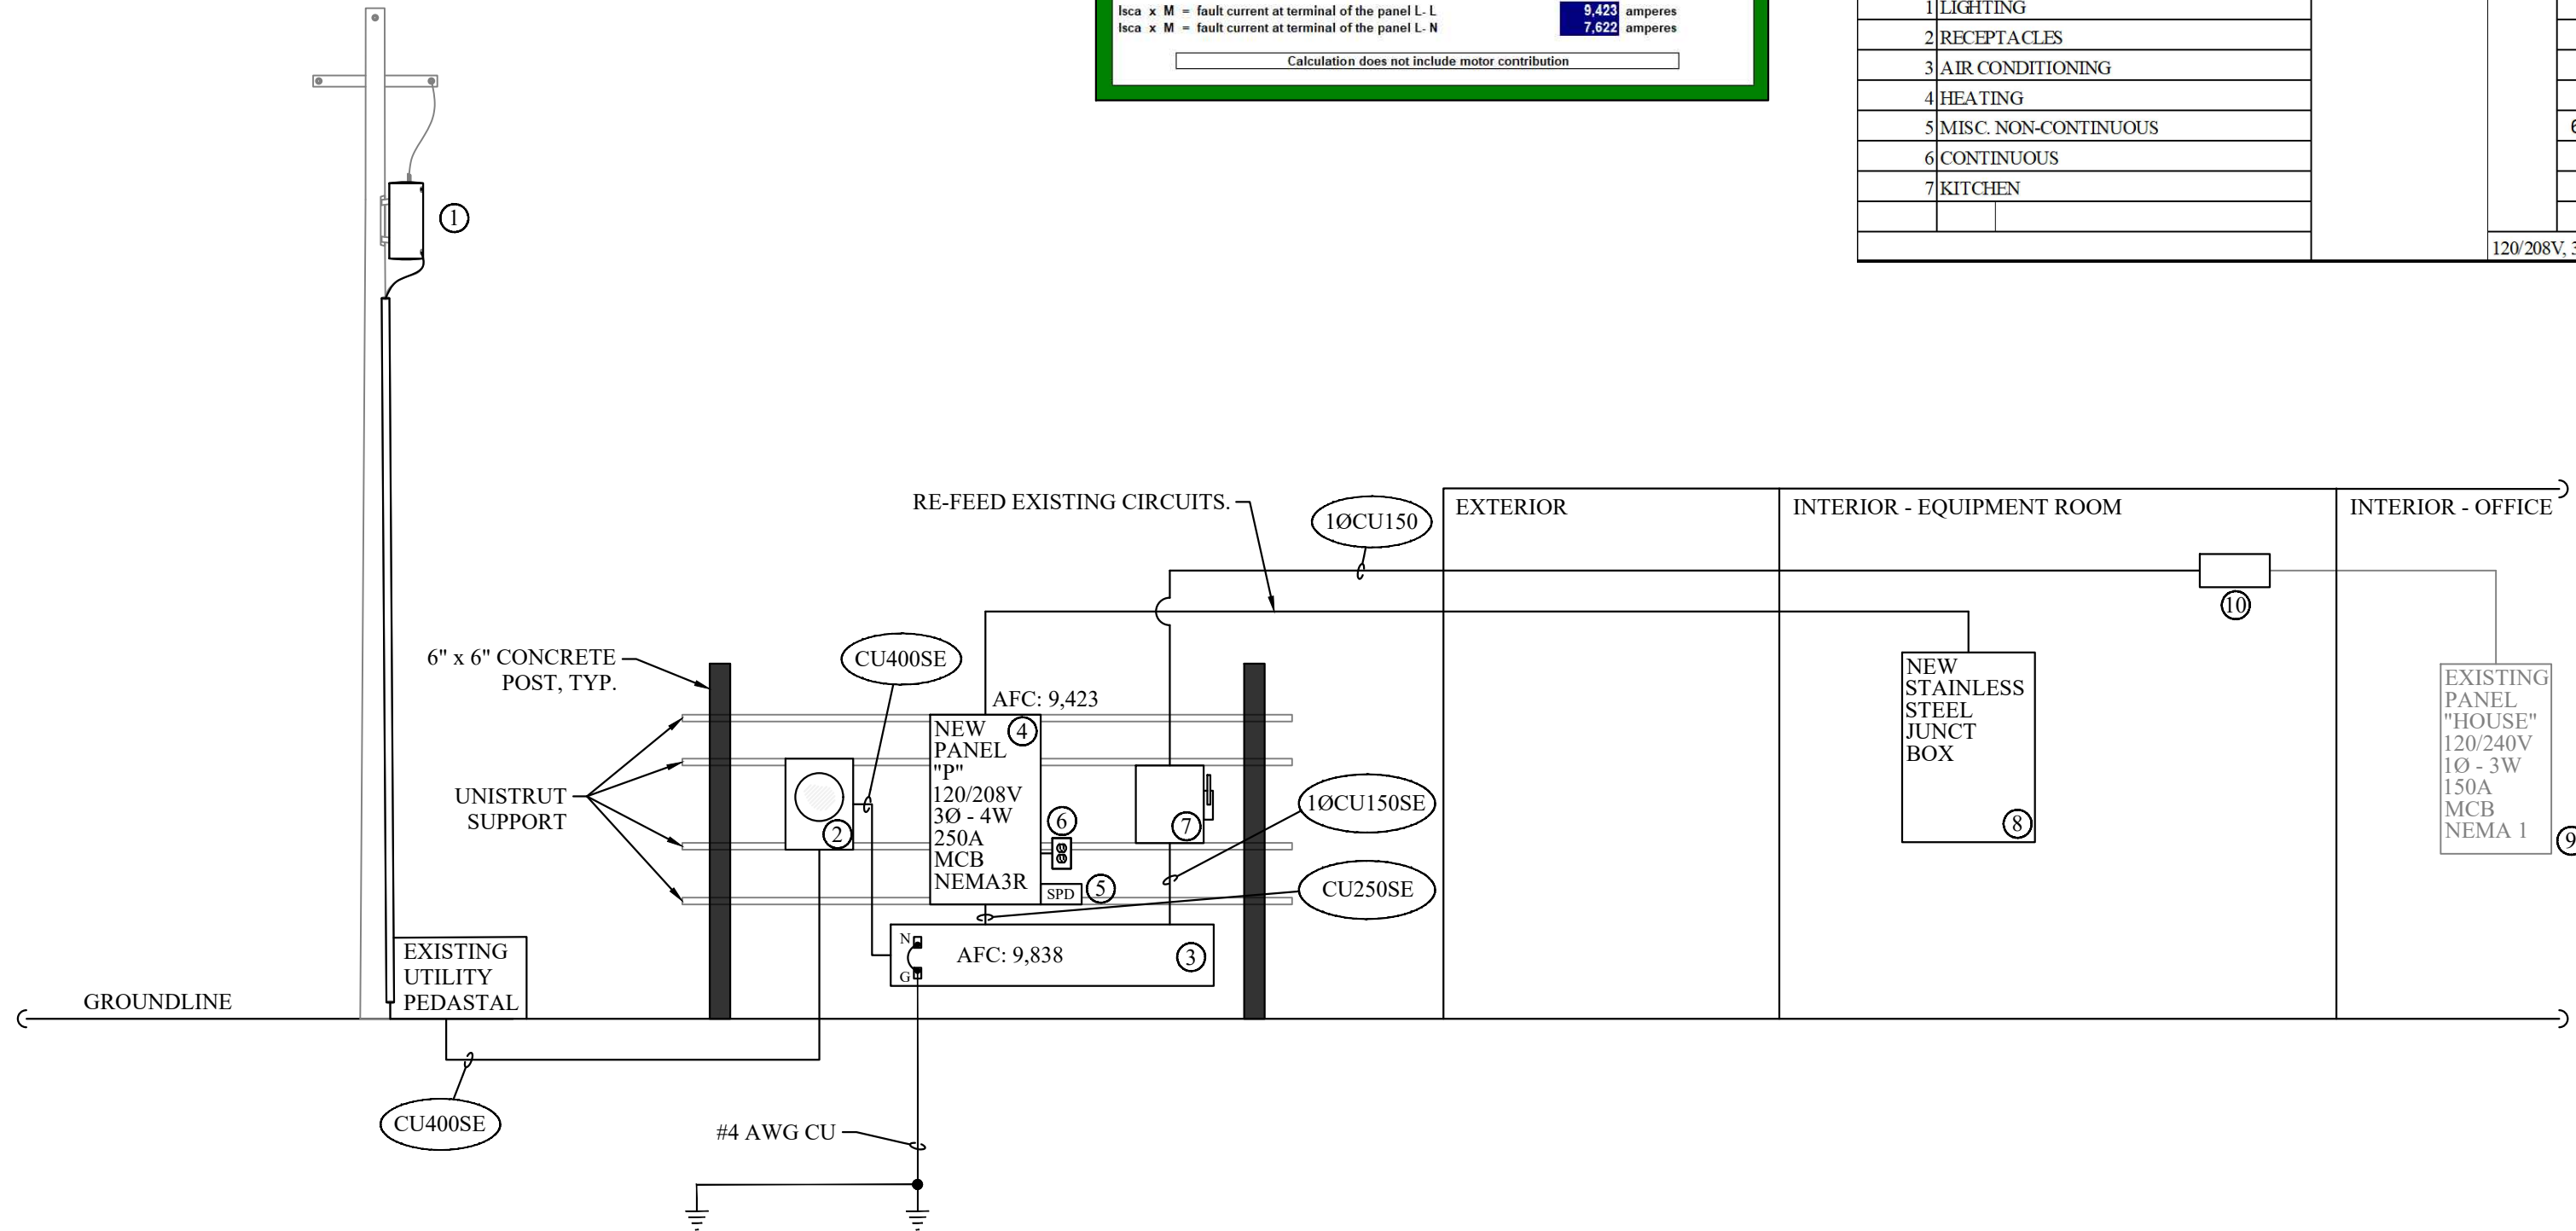

2 POWER RISER DIAGRAM (NEW)
SCALE: NONE



1 POWER RISER DIAGRAM (EXISTING)
SCALE: NONE

PANEL		NEW SURFACE MOUNTED 120/208 VOLT 3 PHASE 4 WIRE WITH GROUND										250 AMP NEMA 3R MCB 10,000 AIC				
LOAD	CKT. NO.	DESCRIPTION	BREAKER TRIP	POLE	VOLT	A	B	C	BREAKER VOLT	POLE	TRIP	DESCRIPTION	CKT. NO.	LOAD		
5	1	POOL CHEMICAL CONTROLLER	20	1	120	500	1440		208	3	20	EXISTING LOAD	2	5		
	3	SPARE	30	2	208			1440	208	3	20	" "	4	5		
	5	" "	30	2	208				208	3	20	" "	6	5		
5	7	EXISTING LOAD	20	1	120	692	1392		120	1	20	NEW EXHAUST FANS (1)	8	5		
	9	SPARE	20	1	120			180	120	1	20	SERVICE RECEPTACLE (1)	10	2		
	11	SPARE	20	1	120				180	120	1	20	TANKLESS WATER HEATER	12	5	
5	13	POOL HEATER CONTROLS	20	1	120	876	700		120	1	20	SUMP PUMP	14	5		
	15	SPARE	20	1	120				120	1	20	SPARE	16			
5	17	WATER HEATER	20	1	120				1500	804	120	1	20	POOL HEATER BLOWER	18	5
	19	SPARE	20	1	120						208	3	20	SPARE	20	
5	21	VACUUM PUMP	20	3	208			1440			208	3	20	" "	22	
5	23	" "	20	3	208				1440		208	3	20	" "	24	
5	25	" "	20	3	208	1440	5760				208	3	80	PUMP 1	26	5
5	27	PUMP 2	80	3	208			5760	5760		208	3	80	" "	28	5
5	29	" "	80	3	208				5760	5760	208	3	80	" "	30	5
5	31	" "	80	3	208	5760	1920				120	1	20	LIGHTS	32	1
	33	SPARE	30	2	208				4320		208	3	60	EXISTING LOAD	34	5
	35	" "	30	2	208					4320	208	3	60	" "	36	5
6	37	(1) SURGE PROTECTION DEVICE	30	3	208	100	4320				208	3	60	" "	38	5
6	39	" "	30	3	208			100			120	1	20	SPARE	40	
6	41	" "	30	3	208				100	1066	120	1	20	POOL HEATER PUMP	42	5
CONNECTED VA SYSTEM VOLTS PHASE AMPS						24000	19000	22370	NOTES ()							
						120/208V, 3 PHASE 208	158	186								
LOAD	LOAD TYPE	CONNECTED	NEC DEMAND	DEMAND LOAD	ELECTRICAL CONTRACTOR TO CONFIRM EXISTING CIRCUITS REQUIRED ON SITE. ELECTRICAL CONTRACTOR TO SUBMIT AS- BUILD DRAWINGS TO ARCHITECT IF THERE ARE ANY DISCREPANCIES FROM CIRCUITS SHOWN IN NEW PANEL P.											
1	LIGHTING	1920	1.25	2400 VA	(1) NEW LOAD											
2	RECEPTACLES	180	1	180 VA												
3	AIR CONDITIONING	0	0	0 VA												
4	HEATING	0	0	0 VA												
5	MISC. NON-CONTINUOUS	63870	1	63870 VA												
6	CONTINUOUS	300	1.25	375 VA												
7	KITCHEN	0	0.65	0 VA												
		TOTAL		66825 VA												
		120/208V, 3 PHASE		186 AMPS												

NOTE:
PRICE NEW EXTERIOR SWITCHGEAR AS
NEMA3R AND PROVIDE LINE ITEM PRICING
TO PROVIDE STAINLESS STEEL COMPONENTS.



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(727) 325-1251
Florida Co# 7819
James Vincent Barnes III, P.E.
Florida P.E. 77754
Pennoni Project No. CLWRC24007

ALL DIMENSIONS MUST BE VERIFIED BY CONTRACTOR
AND OWNER MUST BE NOTIFIED OF ANY
DISCREPANCIES BEFORE PROCEEDING WITH WORK

ROSS NORTON RECREATION
CENTER POOL BUILDING - PHASE 2
1426 S. M.L.K. JR. AVE.
CLEARWATER, FL 33756

DATE	NO.	REVISIONS	BY

ALL DOCUMENTS PREPARED BY PENNONI ASSOCIATES
ARE INSTRUMENTS OF SERVICE IN RESPECT OF THE
PROJECT. THEY ARE NOT INTENDED OR REPRESENTED
TO BE SUITABLE FOR REUSE BY OWNER OR OTHERS ON
THE EXTENSIONS OF THE PROJECT OR ON ANY OTHER
PROJECT. ANY REUSE WITHOUT WRITTEN VERIFICATION
OR ADAPTATION BY PENNONI ASSOCIATES FOR THE
SPECIFIC PURPOSE INTENDED WILL BE AT OWNERS
SOLE RISK AND WITHOUT LIABILITY OR LEGAL
EXPOSURE TO PENNONI ASSOCIATE, AND OWNER SHALL
INDEMNIFY AND HOLD HARMLESS PENNONI ASSOCIATES
FROM ALL CLAIMS, DAMAGES, LOSSES AND EXPENSES
ARISING OUT OF OR RESULTING THEREFROM.

PROJECT	CLWRC24007
DATE	10/21/24
DRAWING SCALE	AS NOTED
DRAWN BY	KTK
APPROVED BY	CAG

E3.0

